Board of Education Capital Plan FY17-FY21

PROJECT TITLE: New Roof Tolland Intermediate School

DATE SUBMITTED:

10/5/2015

			DEPARTMI	ENT PROJECT IN	FORMATION			
Department:	Facilitie	es						
Department Contact:	Peter Sztaba							
Fiscal Year(s) Requested:		FY2017	FY2018	FY2019	FY2020	FY2021		
Department Priority:	Critical	<u>High</u>	Medium	Low				
ype of Project:	Vehicle	Equipme	ent Techn	ology	Facili	ty	Other	

PROJECT DESCRIPTION

Current roof at Tolland Intermediate School will be out of warranty. Roof currently has leaks above the gymnasium areas, and is showing deterioration on the metal flashing, and eroded felts in many sections. Roof is at or near the end of its useful life. Roofing report conducted by SR products that took into consideration the following:

- 1. Current warranties
- 2. Current roof condition based upon physical inspection
- 3. Severity of deferred maintenance
- 4. Size and roof plan
- 5. Replacement with Modified roofing system(better than EPDM as it is more durable when removing snow from roof). Includes all applicable flashing installations, old roof removal, drains and insulation

Estimate-\$1,897,000(includes prevailing wage)

PROJECT NEED

Impact on Department if Recommended or Not Recommended: Water infiltration, safety issues, degradation of physical asset, massive depreciation of building, health risks, increased liability

Cost to Maintain: Preventative maintenance

Describe all Benefits and/or Savings: decrease in roof repairs, decrease in interior repairs(drywall, ceiling tiles, painting, etc), mitigation of liability, improved energy with insulation, reduction in manpower needed to clean up water infiltration, reduced downtime for classes, etc.

PROJECT BUDGET AND FUNDING SOURCES

Project Cost Summary, Recommended Financing Sources, & Operating Budget Impact

Project Cost Elements FY 2017 FY 2018 FY 2019 FY2020 FY2021 TOTAL

Feasibility Study

Design - Engineering

Site Acquisition

Site Improvements

\$1,897,000

Construction:

Inspection Services

Equipment & Furnishings

Vehicle Purchase

Other

Contingency

TOTALS-\$1,897,000

Financing Sources

Lease-Purchase

Water Enterprise Funds

Sewer Enterprise Funds

Solid Waste Enterprise Funds

Storm Water Enterprise Funds

State / Federal Grants

Sale of Surplus Property

CPA

Other (specify)

City Appropriation

TOTALS-\$1,897,000

TOLLAND INTERMEDIATE SCHOOL 96 Old Post Road TOLLAND, CT

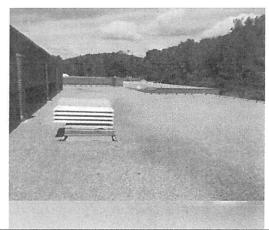


Photo Overview of the West side of the School, #1: Section E



Photo Drain is not clamped down on the West side #2: of Section E

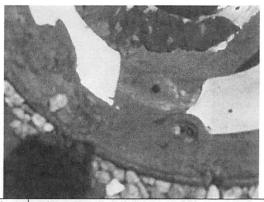


Photo Bolts are not lined up, somehow the drain shifted or was never clamped down to begin with.



Photo Debris along the drain, again on Section E and throughout

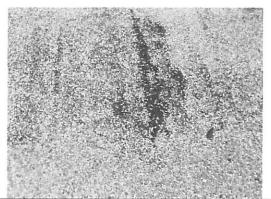


Photo Eroded felts throughout all sections #5:



Photo | Faded aluminum coating along the East side | #6: | perimeter on Section B

TOLLAND INTERMEDIATE SCHOOL 96 Old Post Road TOLLAND, CT



Photo Pitch box with openings on Section B #7:

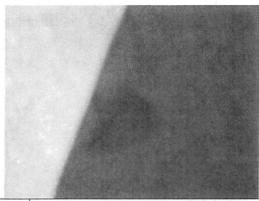


Photo Portable EPDM roof with numerous openings, Section A

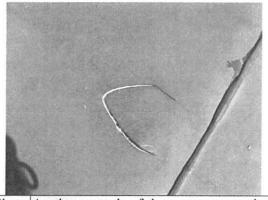


Photo Another example of the numerous openings in the portables, again this is on Section A

Tolland Intermediate School 96 Old Post Road Tolland, CT

Roof Inspection Date

8/11/2015

Roof Identification / Square footage

All roof areas consists of Built-up roofing with modified flashings, with the exception of the EPDM Portables

Total sq. footage of 1991 Built-up area (Sections B, C and D)

Total sq. footage of 1996 Built-up area (Sections E and F)

Total sq. footage of fully adhered EPDM portable Section A

27,177 sq. ft.

43,057 sq. ft.

8,880 sq. ft

Estimated Installation Date

Built-up Sections B, C and D - 1991 Built-up Sections E and F - 1996

EPDM Portable Roof Section A - Estimated 1991

Leak History

Leaks reported along the skylights on Section D

Drainage/Slope

The existing pitch ranges from 1/8" to 1/4" on the low slope areas

Roof Defects/Deficiencies

- Drain on Section E was not clamped down properly
- Leaks reported along skylights on Section D
- Eroded felts throughout
- Pitch boxes fill be topped off
- Deteriorated flashings throughout
- Some of the flashings need to be coated an aluminum coating (Mainly Section B)
- Portable roof (Section A) has at least 20 tears and openings

Overall Roof Condition/Rating Built-up Section and EPDM section

We use a rating system based on the following:

- Roofs rated "Green". These roofs are in good to excellent condition and have 7+ years of additional service life if properly maintained. The roofs need little or no work at this time.
- Roofs rated "Amber". These roofs are in fair condition and have approximately 4 to 6 years of service life remaining if routine preventive maintenance and repairs are performed.
- Roofs rated "Red". These roofs are in poor condition and are at the end of their service life. A maximum of 1 to 3 years of service life may be remaining. Significant repairs are necessary to keep the roofs watertight.

Roof Area	Rating			
All roof areas A through F	Red			

Recommendations and Budgets

Maintenance and Repairs Recommendation

- 1) Repair perimeter flashings as required
- 2) Repair unclamped drain
- 3) Repair all eroded felts as required
- 4) Repair drain and skylight
- 5) Repair opening in flashings and EPDM Portables

Budget \$5000 (PO issued for the work)

Replacement of all the low slope roofs include the following:

- 1) Complete tear off of the existing roof down to the structural decking.
- 2) Installation of new tapered insulation
- 3) Installation of a new roof system with a 20 year warranty
- 4) New metal flashings as required
- 5) Install new Insert drains

Budget for 1991 Sections \$680,000 Budget for 1996 Sections \$1,077,000 Budget for Portable roof \$140,000


SYMBOL TYPE CURB (HVAC) STACK CURB LEGEND PITCHED ROOF FLAT ROOF WALL TYPE 79,112 sq. ft. AREA TOLLAND INTERMEDIATE SCHOOL TABLE OF CONTENTS 96 OLD POST ROAD TOLLAND, CT DRAWING NUMBER 1 - TITLE PAGE 2-ALL ROOFS PAGE # PAGE 1 PAGE 2

TOLLAND INTERMEDIATE SCHOOL 96 OLD POST ROAD TOLLAND, CT

SCALE: NTS

DWG #10F2

KEY DRAWING

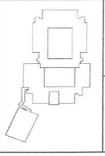

1-TITLE PAGE 51-15-70 DRAWING # : DATE:

 $\frac{1}{2}$ DRAWN BY

REVISION #1


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REVISION #2

REVISION #3

SR PRODUCTS"
CUSTOWER SATISMEND BARCE 1900
1380 E. HOCHAND ROAD
MACEDONIA, OH 44056
440,248,020

The dimensions and square footage on these drawings are colaulated to be within 3-7% of the actual field dimensions. These dimensions are for estimation purposes only and should not be used bidding purposes. Actual dimensions and penetrations can only be determined by measuring the physical structure in the field using proper measuring tools.

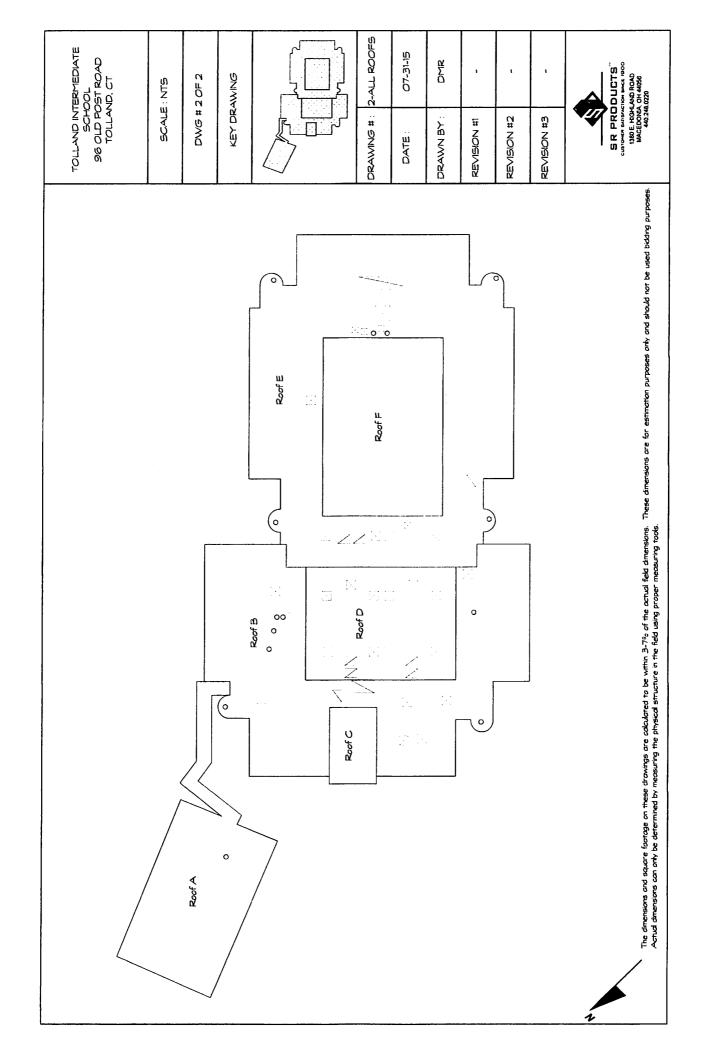

Takeoff Record

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